


- 1) UNDISTURBED / COMPACTED EARTH.
- (2) 2" SQ X 48" LONG STAKES @ 8' OC MAX. 3 36" HT MARAFI #100 N FILTER FABRIC (OR APPROVED SUBSTITUTE) DRAWN
- TIGHT ACROSS STAKES. 4) HAY BALES SET MIN 4" BELOW GRADE. 2" SQ. STAKES HAMMERED THRU HALE BALES (2 STAKES PER BALE).
- EXCAVATE TRENCH AND INSTALL STAKES & FILTER FABRIC AS SHOWN WITH FABRIC LINING TRENCH AND CURLED UP HILL; BACKFILL TRENCH. \*REMOVE TRAPPED SEDIMENT PRIOR TO REMOVAL OF SILT FENCE.

SILT FENCE & HAY BALE DETAIL


SCALE: 1/2" = 1' - 0"

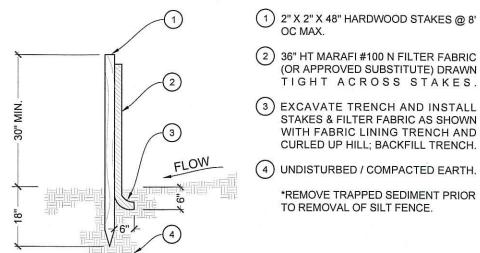

TYPICAL SILT FENCE DETAIL

1.2 SCALE: NTS

- (2) 36" HT MARAFI #100 N FILTER FABRIC (OR APPROVED SUBSTITUTE) DRAWN TIGHT ACROSS STAKES. (3) EXCAVATE TRENCH AND INSTALL STAKES & FILTER FABRIC AS SHOWN
- WITH FABRIC LINING TRENCH AND CURLED UP HILL; BACKFILL TRENCH. (4) UNDISTURBED / COMPACTED EARTH. \*REMOVE TRAPPED SEDIMENT PRIOR TO REMOVAL OF SILT FENCE.

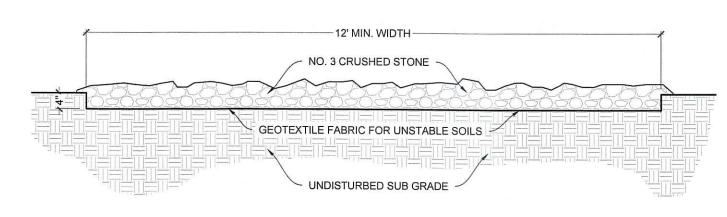


NOTE: INSTALL ANTI-TRACK PAD PRIOR TO THE START OF ANY WORK; PAD SHALL BE MAINTAINED ACROSS THE PROJECT DURATION & SHALL NOT ENCROACH ON DRIP LINES & ROOTS OF EXISTING TREES TO REMAIN.


1.3 ANTI-TRACKING PAD DETAIL SCALE: 1/2" = 1' - 0"

## **GENERAL DETAIL NOTES**

- 01. CONCRETE: ALL CONCRETE SHALL BE AIR-ENTRAINED & INSTALLED IN ACCORDANCE WITH ACI 301 & 318. REINFORCING STEEL SHALL BE ASTM A6 15 GRADE 60 & HAVE 3" OF COVER FOR CONCRETE CAST ON EARTH & 2" FOR CONCRETE EXPOSED TO SOIL OR AIR. INSTALL PLASTIC CHAIRS & SPACERS FOR HORIZONTAL WOVEN MATRICES.
- 02. FOOTINGS: SHALL BEAR ON UNDISTURBED SOIL A MINIMUM OF 42" BELOW FINISHED GRADE OR BE PINNED DIRECTLY TO LEDGE USING A CONSTRUCTION ADHESIVE. INSTALL # 4 RE BAR @ 1' OC, BOTH WAYS, AS A HORIZONTAL WOVEN MATRIX. POUR AT 3,000 PSI & SLUMP NO MORE THAN 5".
- 03. FOUNDATIONS: INSTALL VERTICAL # 4 RE BAR @ 4' OC TIED INTO THE HORIZONTAL FOOTING MATRIX & A CONTINUOUS HORIZONTAL BOND BEAM ACROSS THE TOP OF THE FOUNDATION. POUR AT 3,000 PSI & SLUMP NO MORE THAN 5". FOR CMU FOUNDATIONS, INSTALL DURAWALL TRUSS UNITS EVERY OTHER COURSE & FILL ALL CAVITIES SOLID WITH CONCRETE.
- 04. SLABS: SHALL BEAR ON A 6" THICK BASE OF 3/4" TRAP ROCK COMPACTED IN LIFTS. INSTALL A #4 HORIZONTAL WOVEN MATRIX @ 1' OC BOTH WAYS WITH A 6" SQ. WOVEN WIRE MESH AFFIXED TO THE TOP. SLAB THICKNESS SCHEDULES ARE AS FOLLOWS: NON STRUCTURAL SLABS = 4" THICK MINIMUM, & STRUCTURAL SLABS = 6" THICK MINIMUM. POUR AT 4,500 PSI & SLUMP NO MORE THAN 4".
- 05. CONCRETE STAIRS: INSTALL #4 CONTINUOUS REBAR NOSING INTO EACH RISER. PITCH ALL TREADS A MINIMUM OF 1% TOWARDS LOWER RISERS OR LANDINGS. STAIR SLABS = 6" THICK MINIMUM.
- 06. STONE OR BRICK VENEER WALL UNITS: SHALL BE INSTALLED WITH STAINLESS STEEL WALL TIES CORRECTLY FIXED TO HORIZONTAL CMU JOINTS @ 16" OC BOTH WAYS (NOT SHOWN IN DRAWINGS).

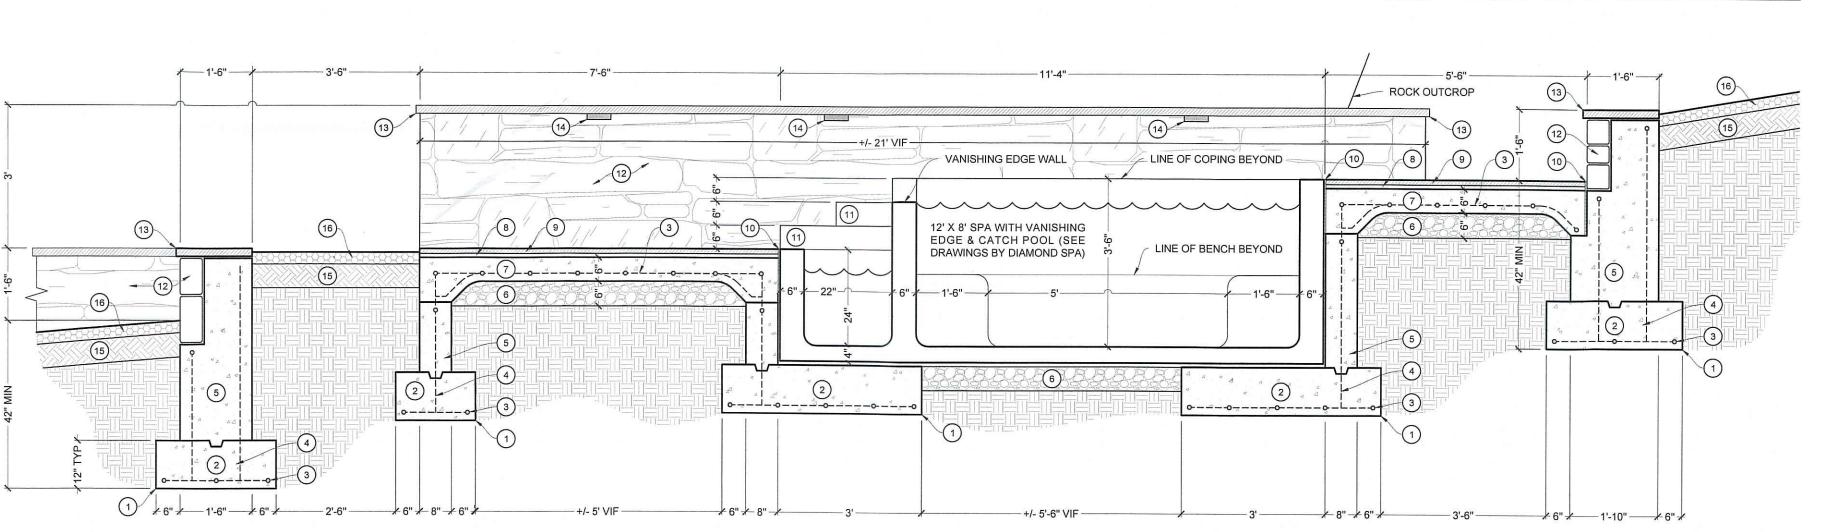

3.1 UPPER & LOWER SPA TERRACE DETAIL SCALE: 1/2" = 1' - 0"

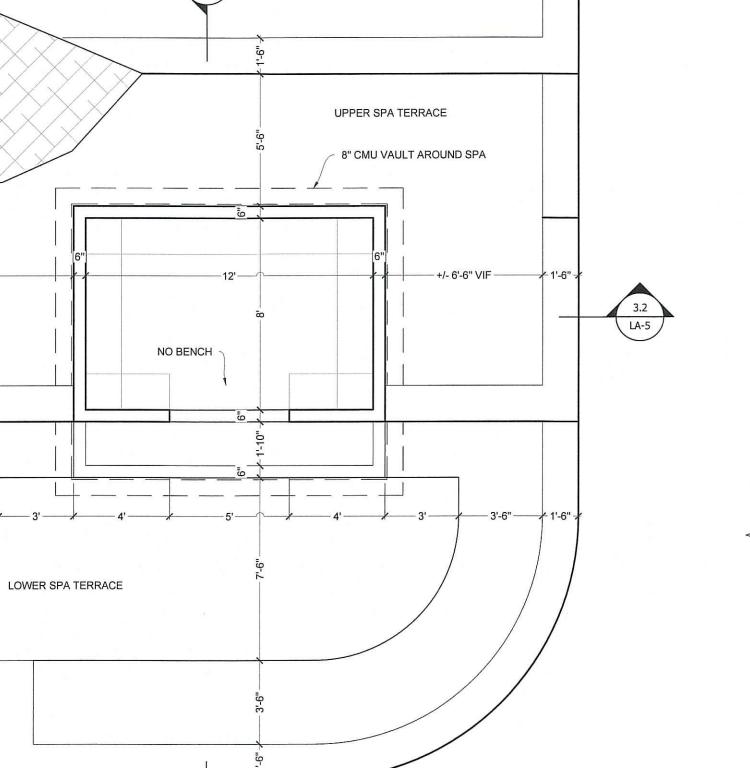

ROCK OUTCROP ROCK OUTCROP 8 9 3 LINE OF COPING BEYOND 12' X 8' SPA WITH VANISHING EDGE & CATCH POOL (SEE LINE OF BENCH BEYOND DRAWINGS BY DIAMOND SPA) — 1'-6" — ★6"★<u>1'-10"</u> ★6"★

SPA TERRACE ENLARGEMENT PLAN
SCALE: 1/4" = 1' - 0"

3.2 SPA TERRACE DETAIL SCALE: 1/2" = 1' - 0"

LEGEND FOR DRAWINGS 3.1 & 3.2

1) UNDISTURBED EARTH OR SUITABLE BASE MATERIAL COMPACTED TO 95%.

3 # 4 HORIZONTAL RE BAR WOVEN @ 1' OC BOTH WAYS (FOOTINGS & SLABS).

5 CMU OR CONCRETE FOUNDATION / STEM WAL; SEE NOTES ABOVE.

(7) CONCRETE SLAB @ 4,000 PSI & MAX # 5 SLUMP; THICKNESS AS SHOWN.

9 PAVING UNITS: +/- 1-1/4" THICK THERMAL FLAGGING ON CONCRETE.

SLAB STEPS: 6" ROCK-FACED RISERS X 14" THERMAL TREADS X 6' WIDE.

(13) — 2" THICK THERMAL STONE CAP WITH 1" OVERHANG ON EXPOSED FACE.

12 STONEWORK: USE STAINLESS STEEL WALL TIES @ 16" OC BOTH WAYS.

(14) CAST LED WALL LIGHT: SEE PLANTING & LIGHTING PLAN ON LA-3...

(16) -- MIN. 3" THICK BROWN (NON-DYED), QUALITY SHREDDED BARK MULCH.

15) LOAM OR PLANTING MEDIUM INSTALLED IN UNIFORM DEPTH AS SHOWN.

2) AIR-ENTRAINED CONCRETE FOOTING @ 3,000 PSI & MAXIMUM # 5 SLUMP.

4 + 4 VERTICAL RE BAR @ 4' OC ACROSS FOUNDATIONS & CMU CAVITIES.

(6) -- 3/4" TRAP ROCK COMPACTED IN 6" LIFTS WITH THICKNESS AS INDICATED.

8) MORTARED SETTING BED ON CONCRETE +/- 1" DEPTH OR AS INDICATED.

1/2" PRE-MOLDED NON-EXTRUDING EXPANSION JOINT & ELASTIC GROUT.


If professional Seal is not in a contrasting color, this sheet is a copy.

SITE DETAILS

BRUECK RESIDENCE

> 40 GOODWIVES RIVER ROAD DARIEN, CT

The drawings, notes, & specifications contained herein are instruments of professional service, protected under copyright law, & the exclusive property of Wagner Pools. Authorized project representatives are granted a non-exclusive right to use these materials expressly for the purposes of this project.

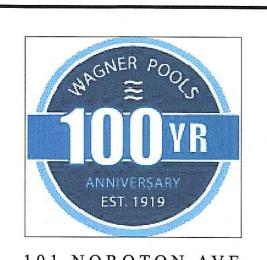

101 NOROTON AVE. DARIEN, CT 06820 (203) 655-0766

April 6, 2020 Drawn By: Scale: As Noted North:

LA-5